






address. Suite 8, 11 White Street Tamworth NSW 2340 phone. 1300 BARNSON (1300 227 676) email. generalenquiry@barnson.com.au barnson.com.au web.

THIS DRAWING IS TO BE READ IN CONJUNCTION WITH GENERAL BUILDING

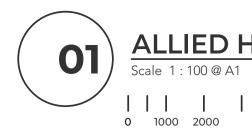

### AREAS

TENANCY 1 - DEM
TENANCY 2
TENANCY 3 -
EXTERNAL PAVEN
TOTAL G.F.A =

Project. PROPOSED MEDICAL CENTRE DEVELOPMENT Site Address. HILLVUE ROAD, SOUTH TAMWORTH NSW 2340 LOT 2 - DP1264030 Client. TAMWORTH ABORIGINAL MEDICAL SERVICE

OF THIS DRAWING MAY BE REPRODUCED IN ANY WAY WITHOUT THE WRITTEN PERMISSION OF BARNSON PTY LTD.

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12.05.2023 PRELIMINARY 29.05.2023 CONCEPT 26.07.2023 ISSUED FOR GRANT APPLICATION 01.12.2023 ISSUE FOR REVIEW 22.12.2023 ISSUE FOR APPROVAL 19.01.2024 ADD TENANCY 3 LAYOUT G 29.01.2024 ISSUE FOR DA

# ALLIED HEALTH - FLOOR PLAN

**0** 1000 2000 4000 10000

ENTAL	295m <sup>2</sup>	
	172m <sup>2</sup>	
	167m <sup>2</sup>	
EMENTS	331m <sup>2</sup>	

634m<sup>2</sup>

LEGEND

## **DEVELOPMENT APPLICATION**



Project No.

1:100 @ A1 Drawn.


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LO



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LEGEND



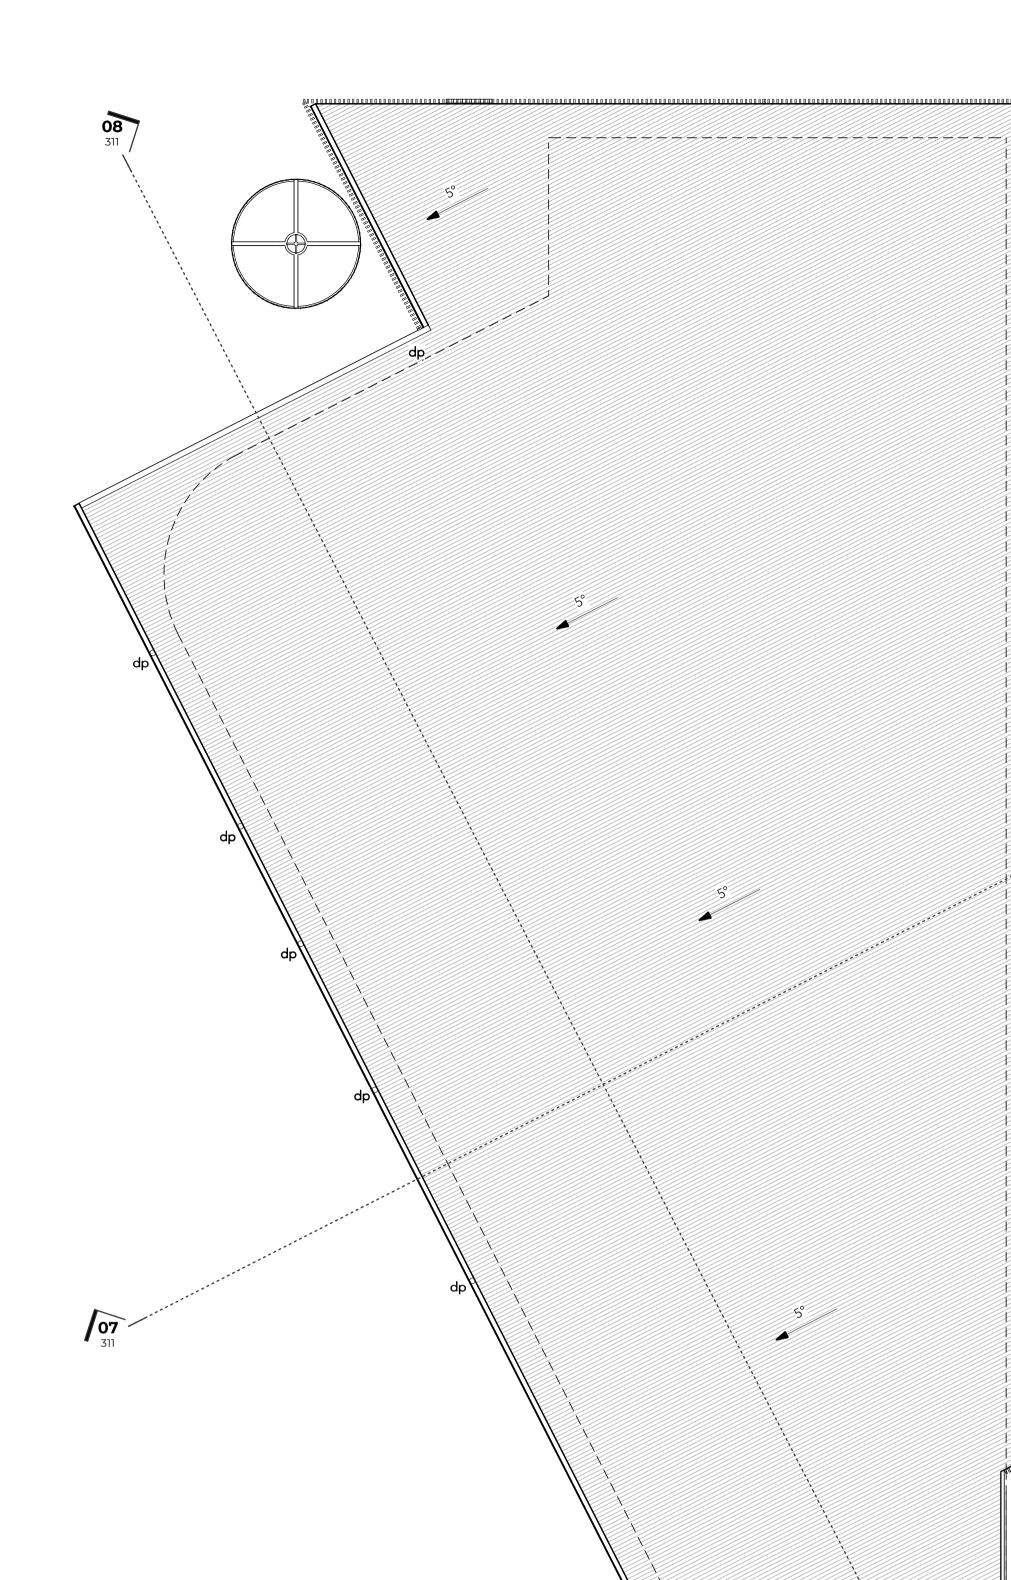

### BARNSON PTY LTD

address. Suite 8, 11 White Street Tamworth NSW 2340 phone. 1300 BARNSON (1300 227 676) email. generalenquiry@barnson.com.au barnson.com.au web.



07

Scale 1:100@A1 0 1000 2000

Downpipes are to be located where they will not create a hazard to building users nor impede window & door openings & the like. They are to be installed as close as practicable to the supporting structure while maintaining termite inspection clearances of 25mm. Downpipes are to be protected from potential mechanical damage, be installed no less than 100mm from electrical cables & cables & gas pipes & no less than 50mm from other services in accordance with AS/NZS3500.3.2 & civil design prepared by Barnson.

The proposed roofing must be installed to prevent water penetration into the building structure in accordance with the stormwater management plan prepared by Barnson.

All sarking material to be installed according to manufacturer's installation instructions, 'AS/NZS4200.1 & 2-2017 -Installation of pliable membrane & underlay' & the BCA Vol. 1, F1.6.

by Barnson.

**08** 311

Amendment. 26.07.2023 ISSUED FOR GRANT APPLICATION

ISSUE FOR REVIEW 01.12.2023

22.12.2023 ISSUE FOR APPROVAL

Date.

19.01.2024 ADD TENANCY 3 LAYOUT G 29.01.2024 ISSUE FOR DA

Project. PROPOSED MEDICAL CENTRE DEVELOPMENT Site Address. HILLVUE ROAD, SOUTH TAMWORTH NSW 2340 LOT 2 - DP1264030

Client. TAMWORTH ABORIGINAL MEDICAL SERVICE

## **ROOF PLAN**

4000



# **ROOFING NOTES.**

Steel roof sheeting is to be installed in accordance with manufacturer's installation instructions, AS1562.1 Design & installation of sheet roof & wall cladding - metal & the BCA Vol. 1, Part F1.5.

10000

Roofing to be installed as per AS/NZS3500.3. and stormwater management plan prepared by Barnson.

Downpipes throughout in accordance with civil design prepared by Barnson.

Corrosion protection of metal roof sheeting is required to meet with minimal coating requirements of manufacturer. Gutters, downpipes & flashing fabricated with metal are to meet AS/NZS2179 requirements while uPVC

components are to comply with AS1273.

No lead roofing products are to be specified to prevent toxins from entering any potential potable rainwater catchment supplies.

Eave gutters must have a 1:500 minimal fall & designed in accordance with stormwater management plan prepared

Any flexible ducting that has a source from a flame hazard must meet AS4254 hazard properties.


Provide dektite pipe flashing or similar to roof pipe penetrations. Install in strict accordance with manufacturers recommendations, providing free drainage of water from around the areas of installation

A roof anchorage & safety system is to be designed, installed & certified certified in accordance with AS1891.4 -2000. Building owner is to ensure annual maintenance & inspection of system.

Roof sheets to be lapped away from prevailing weather ingress in accordance with AS1562.1.

Install sarking over battens & under roof sheeting for improved moisture drainage.

## **DEVELOPMENT APPLICATION**

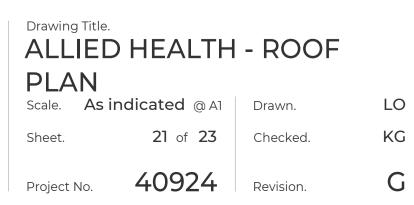

Drawing No.






\_\_\_\_\_\_ rl:\_\_\_405.45 m\_max height


aluminium batten screening			
— 'colorbond' steel vertical cladding ———— aluminium framed glazed fixed window ————			




 'colorbond' steel oof sheeting
aluminium batten screening
'colorbond' steel
vertical cladding
aluminium framed glazed fixed window

	max height 405.45 m rl	:
— aluminium batten screening	ceiling level 401.85 m rl	
— masonry blockwork wall		
— aluminium framed fixed glazing	floor level 398.25 m rl	:

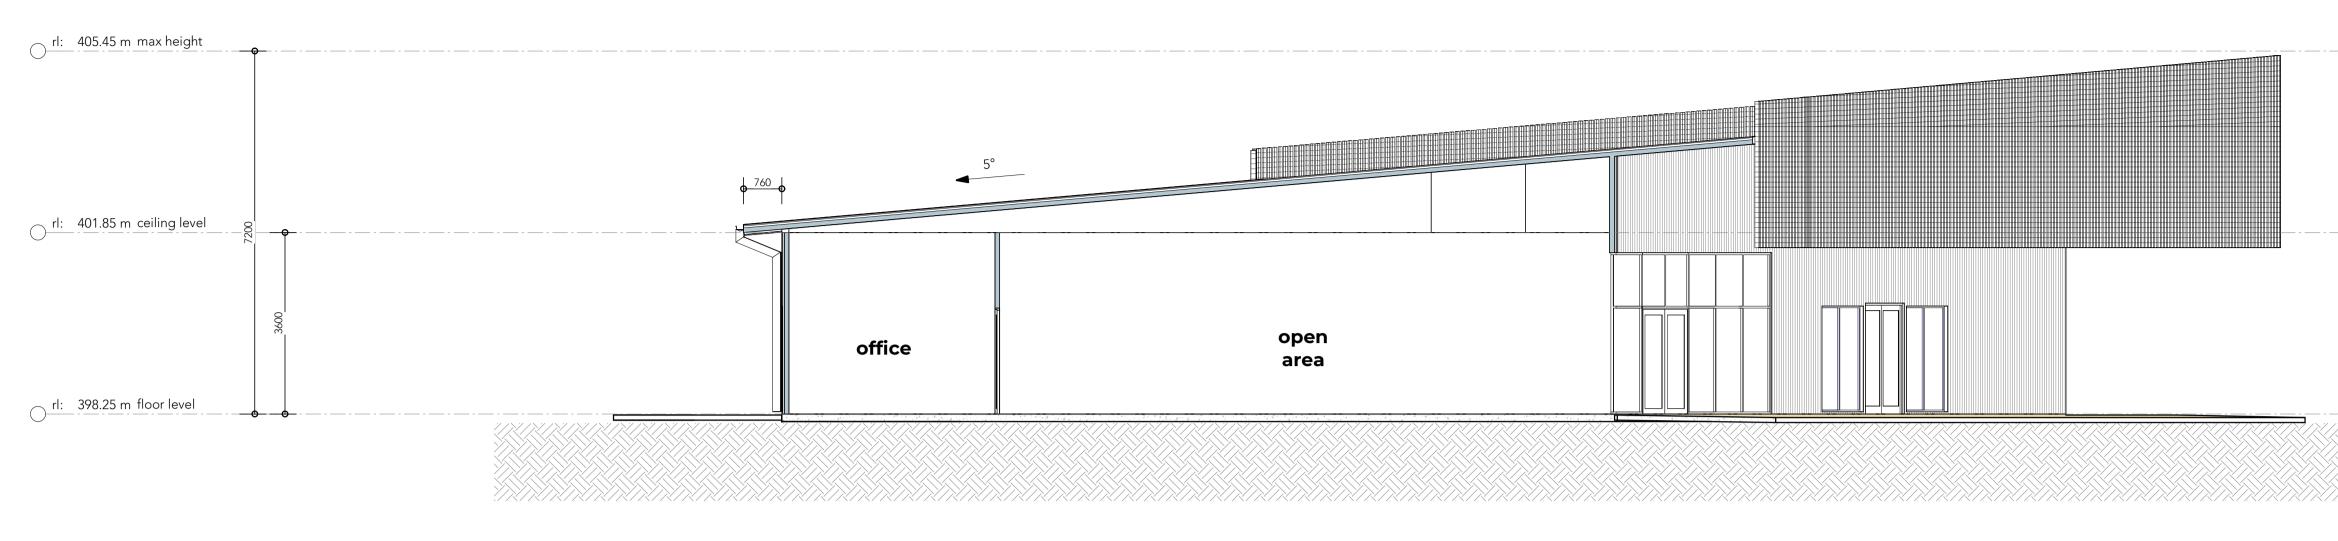

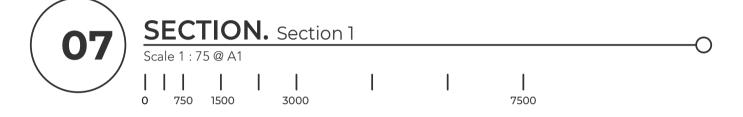

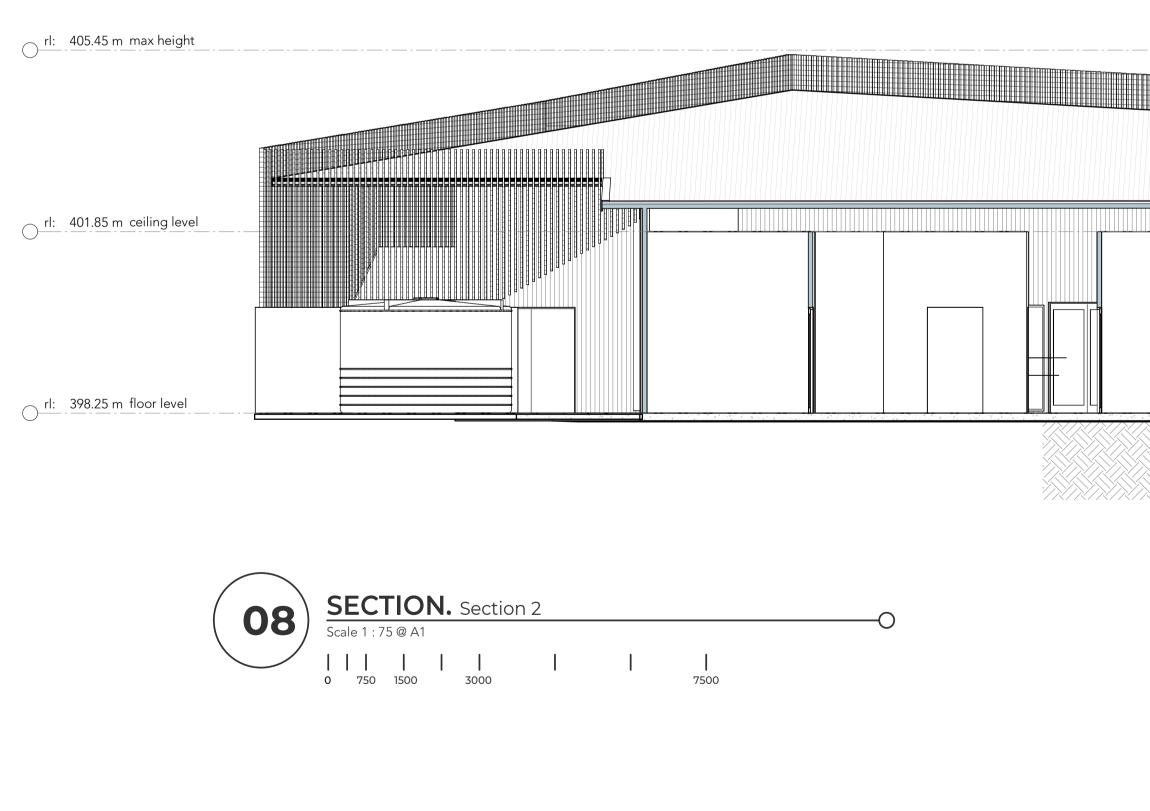





### BARNSON PTY LTD


ddress.	Suite 8, 11 White Street Tamworth NSW 2340						
hone.	1300 BARNSON (1300 227 676)						
mail.	generalenquiry@barnson.com.au						
veb.	barnson.com.au						
ONSULTAN	ING IS TO BE READ IN CONJUNCTION WITH GENER ITS DRAWINGS APPLICABLE TO THIS PROJECT. ALI I'KED ON SITE BEFORE COMMENCEMENT OF WORI						

open ai	rea				

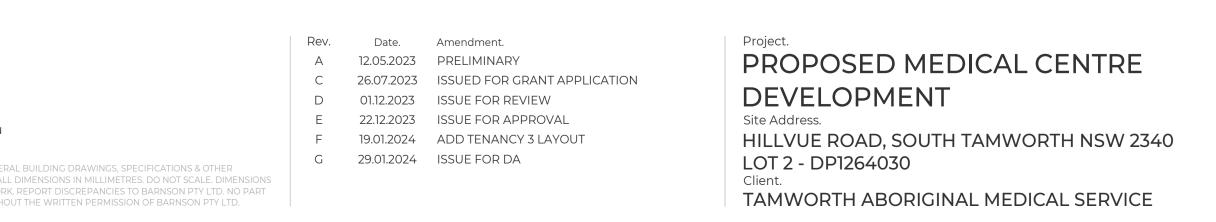

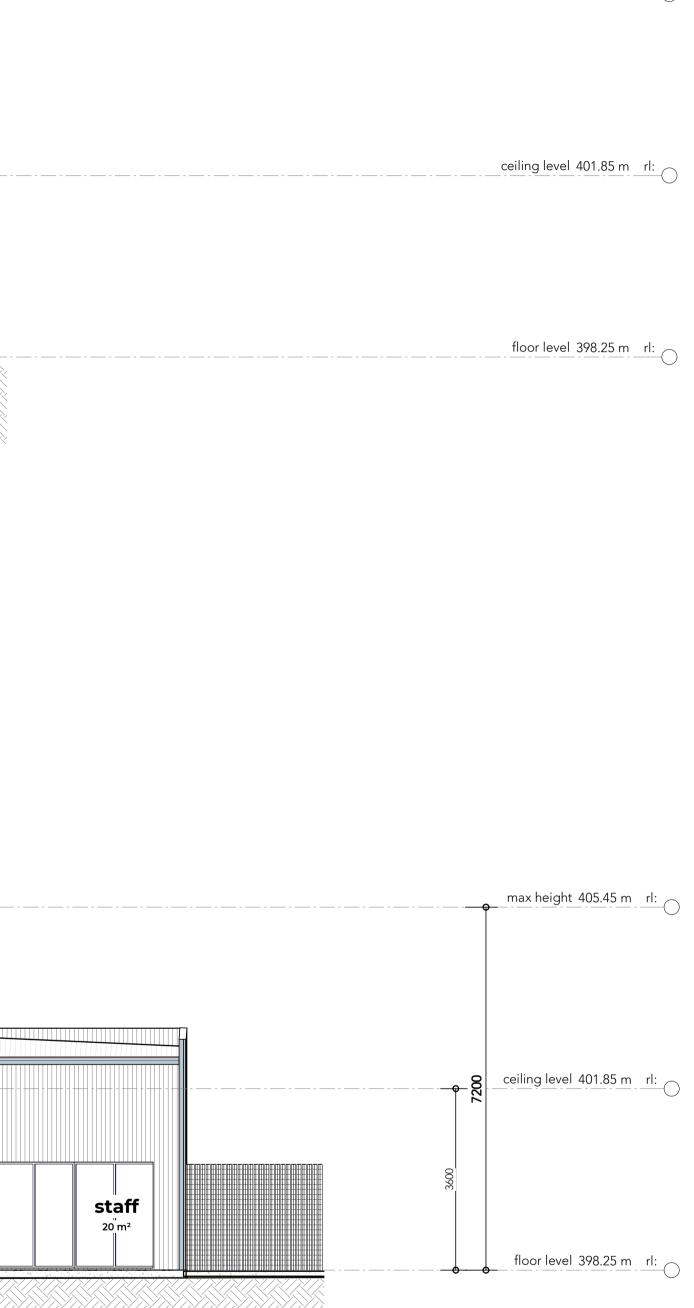

## **DEVELOPMENT APPLICATION**

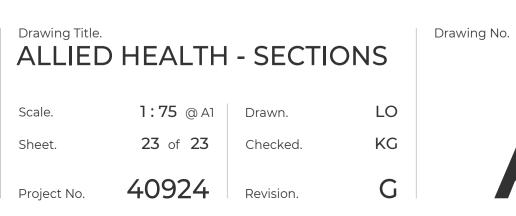



\_\_\_\_\_max\_height\_405.45 m \_\_\_rl: